

August 1, 2025

**ADDENDUM NO. 2
TOLEDO BEND PROJECT JOINT OPERATION
Hydro Station Outage Unit #2 RFB# 26-001**

THIS ADDENDUM IS ISSUED FOR THE PURPOSE OF AMENDING THE CONTRACT DOCUMENTS FOR THE SABINE RIVER AUTHORITY OF TEXAS AND SABINE RIVER AUTHORITY OF LOUISIANA AS FOLLOWS:

Clarifications: The following items were discussed at the pre bid meeting, and provided for further clarification and contractor information.




- Scaffolding - Contractor to provide necessary scaffolding for access to the turbine for work on the runner blades, wicket gates, and associated areas in the draft tubes. Payment is incorporated into Bid Item #2 Pre Outage Work.
- Safety - SRA will provide safety items for Air Monitoring in confined space areas. Contractor to coordinate with SRA on use and locations.
- Lockout/Tagout Procedures- SRA has in-house procedures for lockout/tagout of the electrical and equipment. SRA will review with the contractor at the start of construction and provide training for contractor of site-specific procedures.
- Confined Space - SRA has in-house procedures for confined space entry of the powerhouse work areas. SRA will review with the contractor at the start of construction and provide training for contractor of site-specific procedures.
- Paint Coating - The areas to be coated are undefined until the unit is off line and dewatered. The coating system will be included as part of the allowances for Bid Items 12 & 13.

Plans: Plan sheets PS-5 & PS-6 are hereby included with the contract documents for contractor information regarding elevations, and dimensional information of the generator draft tubes.





August 1, 2025

END

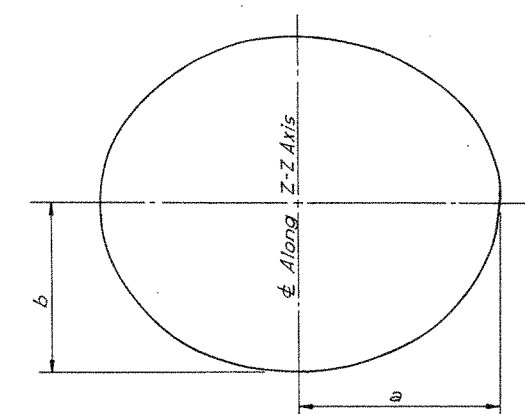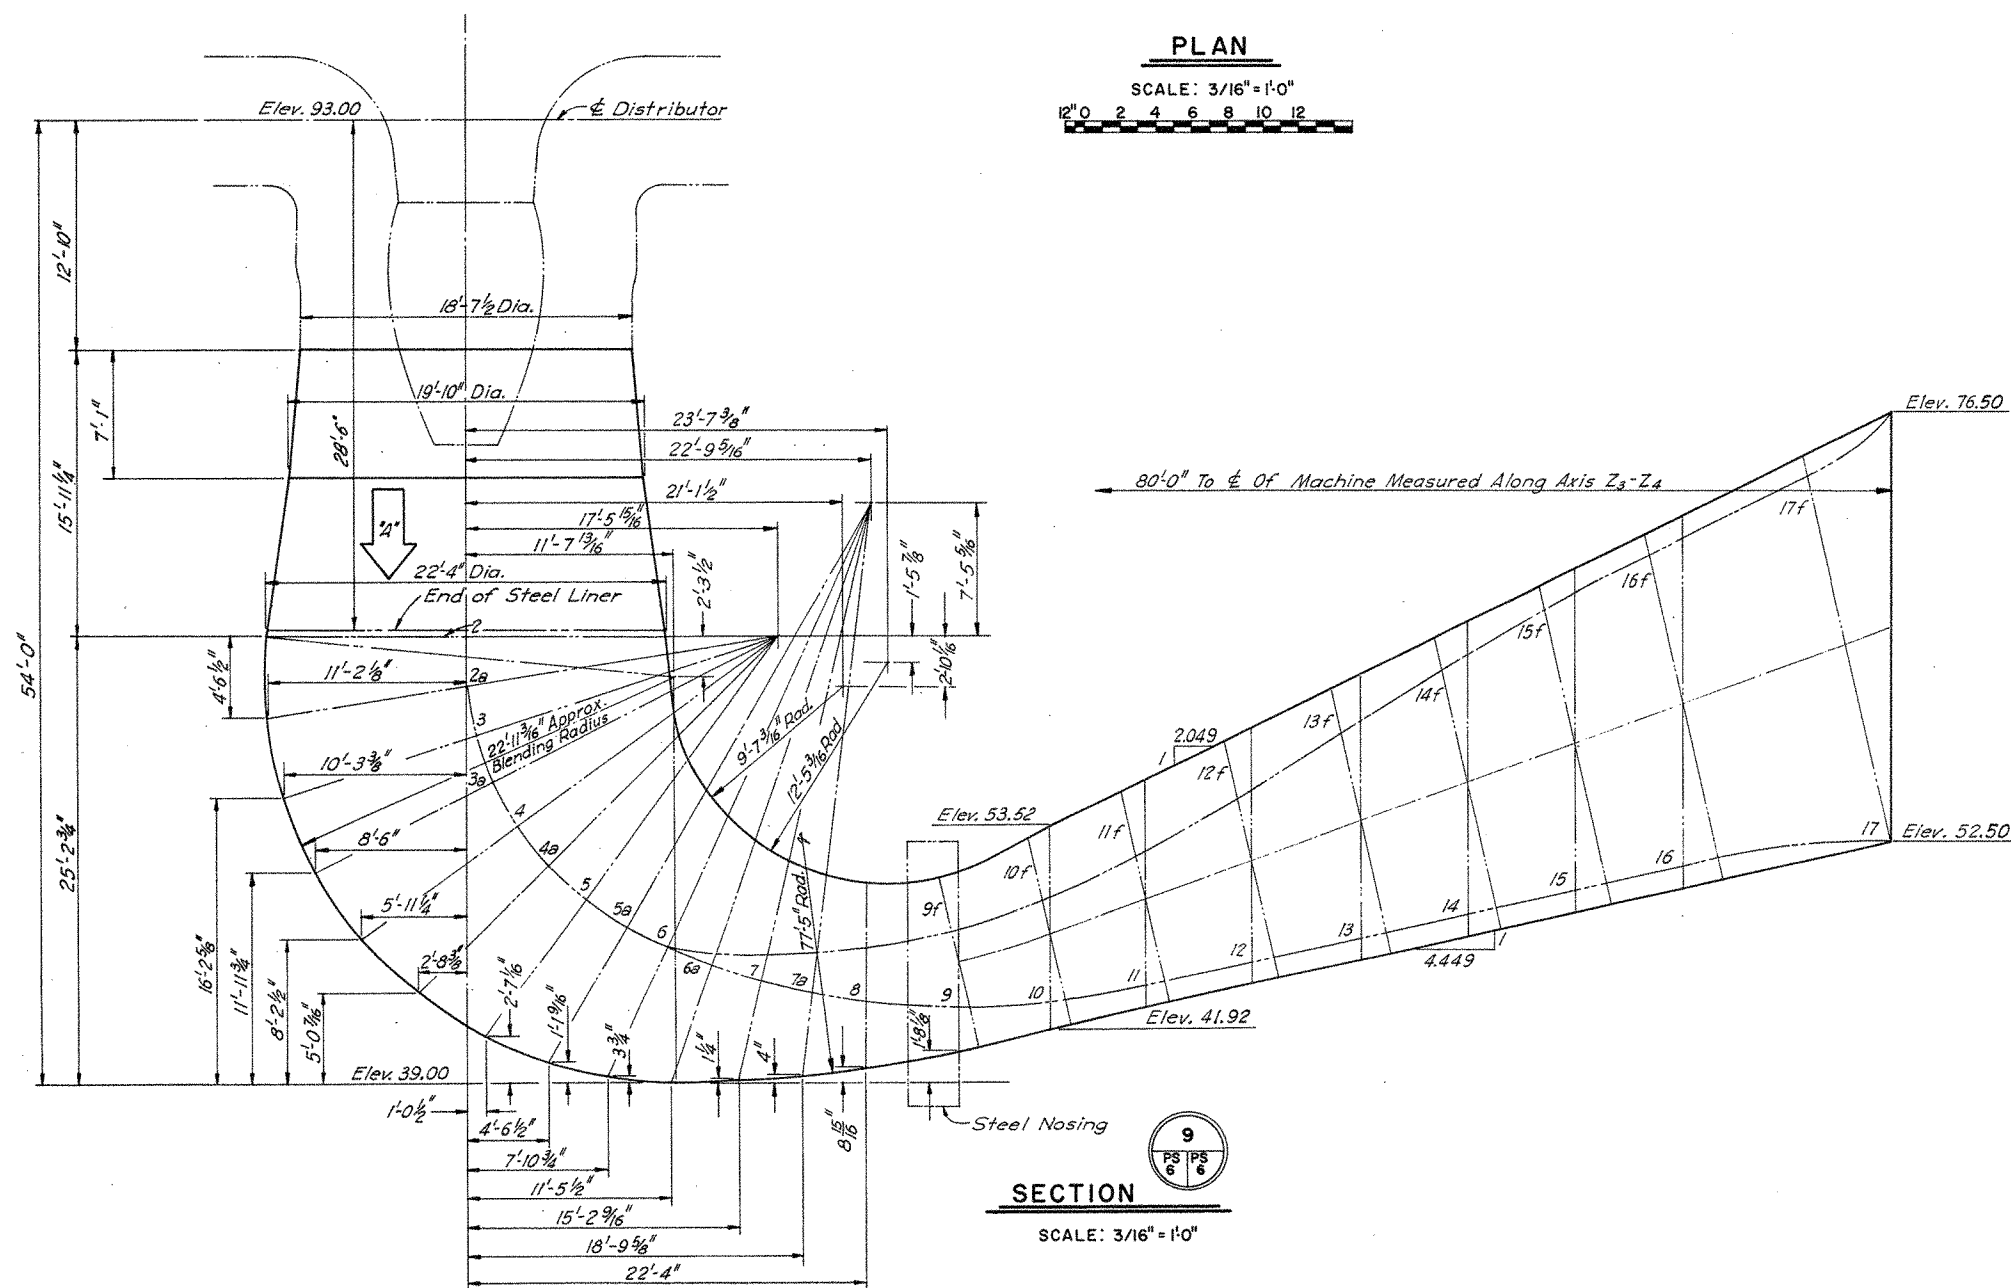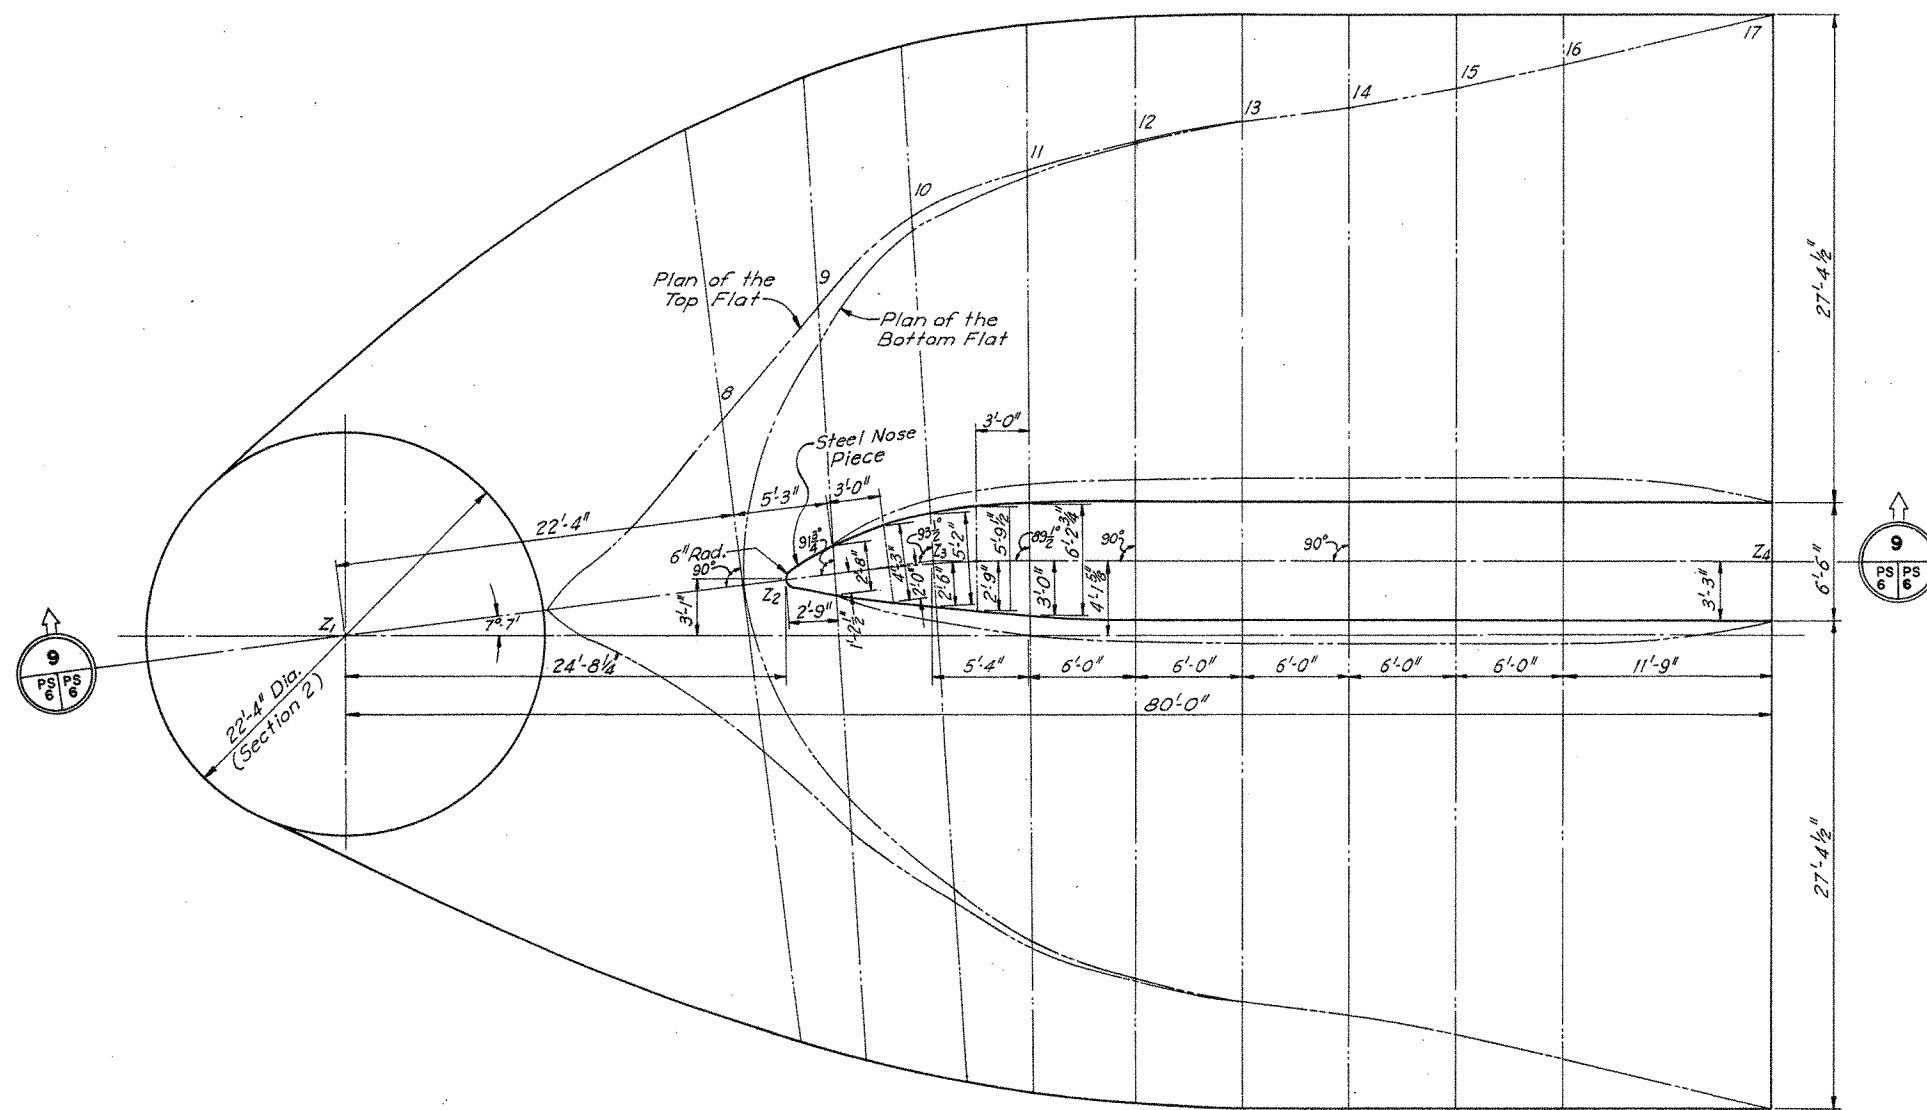

Section	a	b
2a	11'-5 3/8"	11'-4 1/2"
3	12'-0 3/4"	11'-4 3/8"
3a	12'-11 1/2"	11'-2 3/8"
4	14'-0 1/2"	10'-10 1/8"
4a	15'-4 1/8"	10'-4 1/8"
5	16'-9 3/8"	9'-8 1/2"
5a	18'-4"	8'-11"
6	19'-9"	8'-1 1/8"

SECTION 2a TO 6
NOT TO SCALE

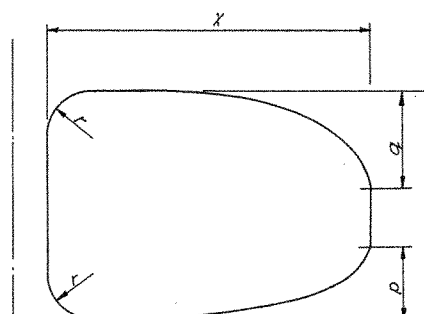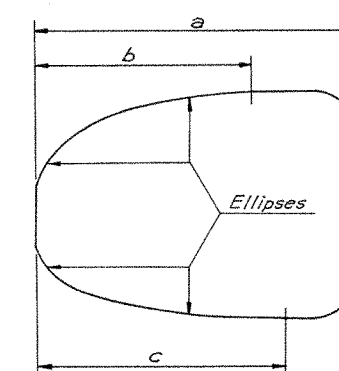

Both Sides Of Draft Tube Are Identical Except Dimension "X" and "a" Viewed Downstream From E Section.


Section	a	b	c	d	e	f	g	h	i	j	k	l	m	n	o	p	q	r	s	t	u	v	w	x	y	z
9	26'-2"	12'-10"	14'-9 1/2"	10'-3 3/8"	2'-6"	3'-3"	0	26'-2"																		
10	26'-3 1/2"	9'-9"	10'-6"	11'-7 5/8"	1'-6"	3'-11"	8 1/2"	26'-6"																		
11	26'-7"	8'-1"	8'-4 1/2"	13'-0 1/2"	1'-3"	4'-0"	1'-0"	26'-7"																		
12	27'-0"	6'-10 1/2"	6'-11"	14'-7 1/8"	1'-3"	3'-6"	1'-2"	27'-0"																		
13	27'-4"	6'-0"	6'-0"	16'-2 1/8"	1'-3"	2'-7 1/2"	1'-3"	27'-4"																		
14	27'-4 1/2"	5'-3"	5'-3"	17'-9"	1'-3"	1'-10"	1'-3"	27'-4 1/2"																		
15	27'-4 1/2"	4'-2"	4'-2"	19'-3 3/8"	1'-3"	1'-4 1/2"	1'-3"	27'-4 1/2"																		
16	27'-4 1/2"	2'-10"	2'-10"	20'-10 1/8"	1'-3"	1'-3"	1'-3"	27'-4 1/2"																		
17	27'-4 1/2"	0	0	24'-0"	0	0	0	27'-4 1/2"																		

Sections Viewed From Upstream In Direction of Arrow "A"


SECTION 9 TO 17
NOT TO SCALE

- NOTES
1. Outlines and details from English Electric Co. Drawings No. L 667/169 Sheets 1 & 2.
 2. Dimensions defining Sections are identical on both sides of the Central Pier except Section 10.
 3. Dimensioning in small fractions of an inch does not imply that the same accuracy is expected in concrete.
 4. Where, for convenience, the drawing is overdimensioned, the exact calculation may show small discrepancies between two dimensions defining the same point. Providing the discrepancies are not such as to lead to the obvious discontinuities of the outline, or to cast doubt as to the designer's intention, they should be disregarded.


REVISION	DATE	DESCRIPTION	BY
<p align="center">SABINE RIVER AUTHORITIES OF TEXAS AND LOUISIANA SABINE RIVER, TEXAS AND LOUISIANA</p> <p align="center">TOLEDO BEND DAM AND RESERVOIR</p> <p align="center">POWER PLANT - CONCRETE DRAFT TUBE NEAT LINES</p> <p align="center">FORREST AND COTTON, INC. CONSULTING ENGINEERS DALLAS, TEXAS</p>			
DESIGNED BY: E.E.	CHECKED BY: E.W.P.		
DRAWN BY: T.E.S.	RECOMMENDED: A.M. J.C.B.		
TRACED BY: T.E.S.	APPROVED: [Signature]		
FILE NO. 522-01-283	CONTRACT NO. TB-8		
DATE 8 Nov. 1963	SHEET PS-6 OF PS-151		

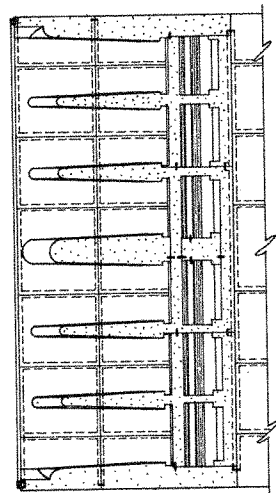


SECTION 5
SCALE: 1" = 30'-0"

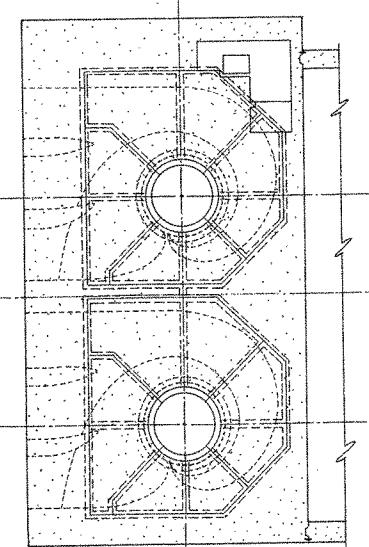


SECTION 6
SCALE: 1" = 30'-0"

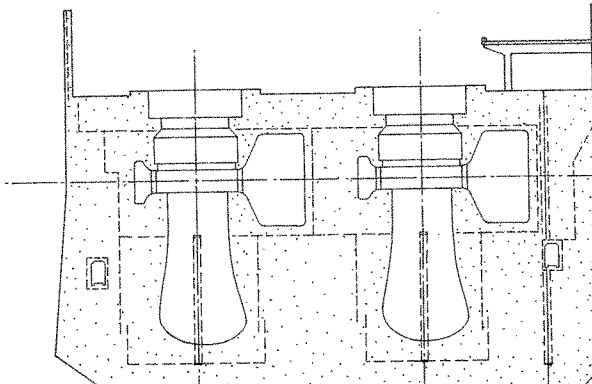


SECTION 7
SCALE: 1" = 30'-0"

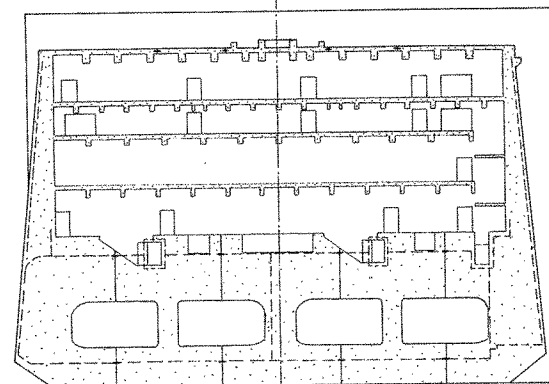


SECTION 8
SCALE: 1" = 30'-0"

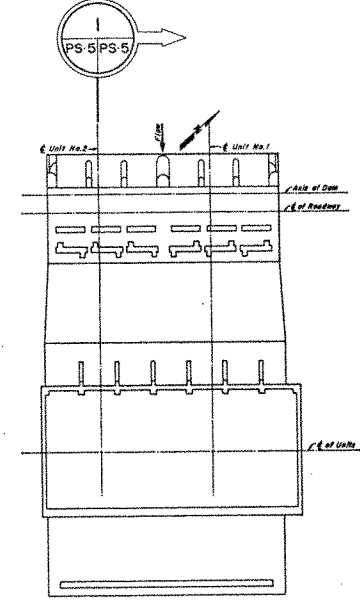


KEY PLAN

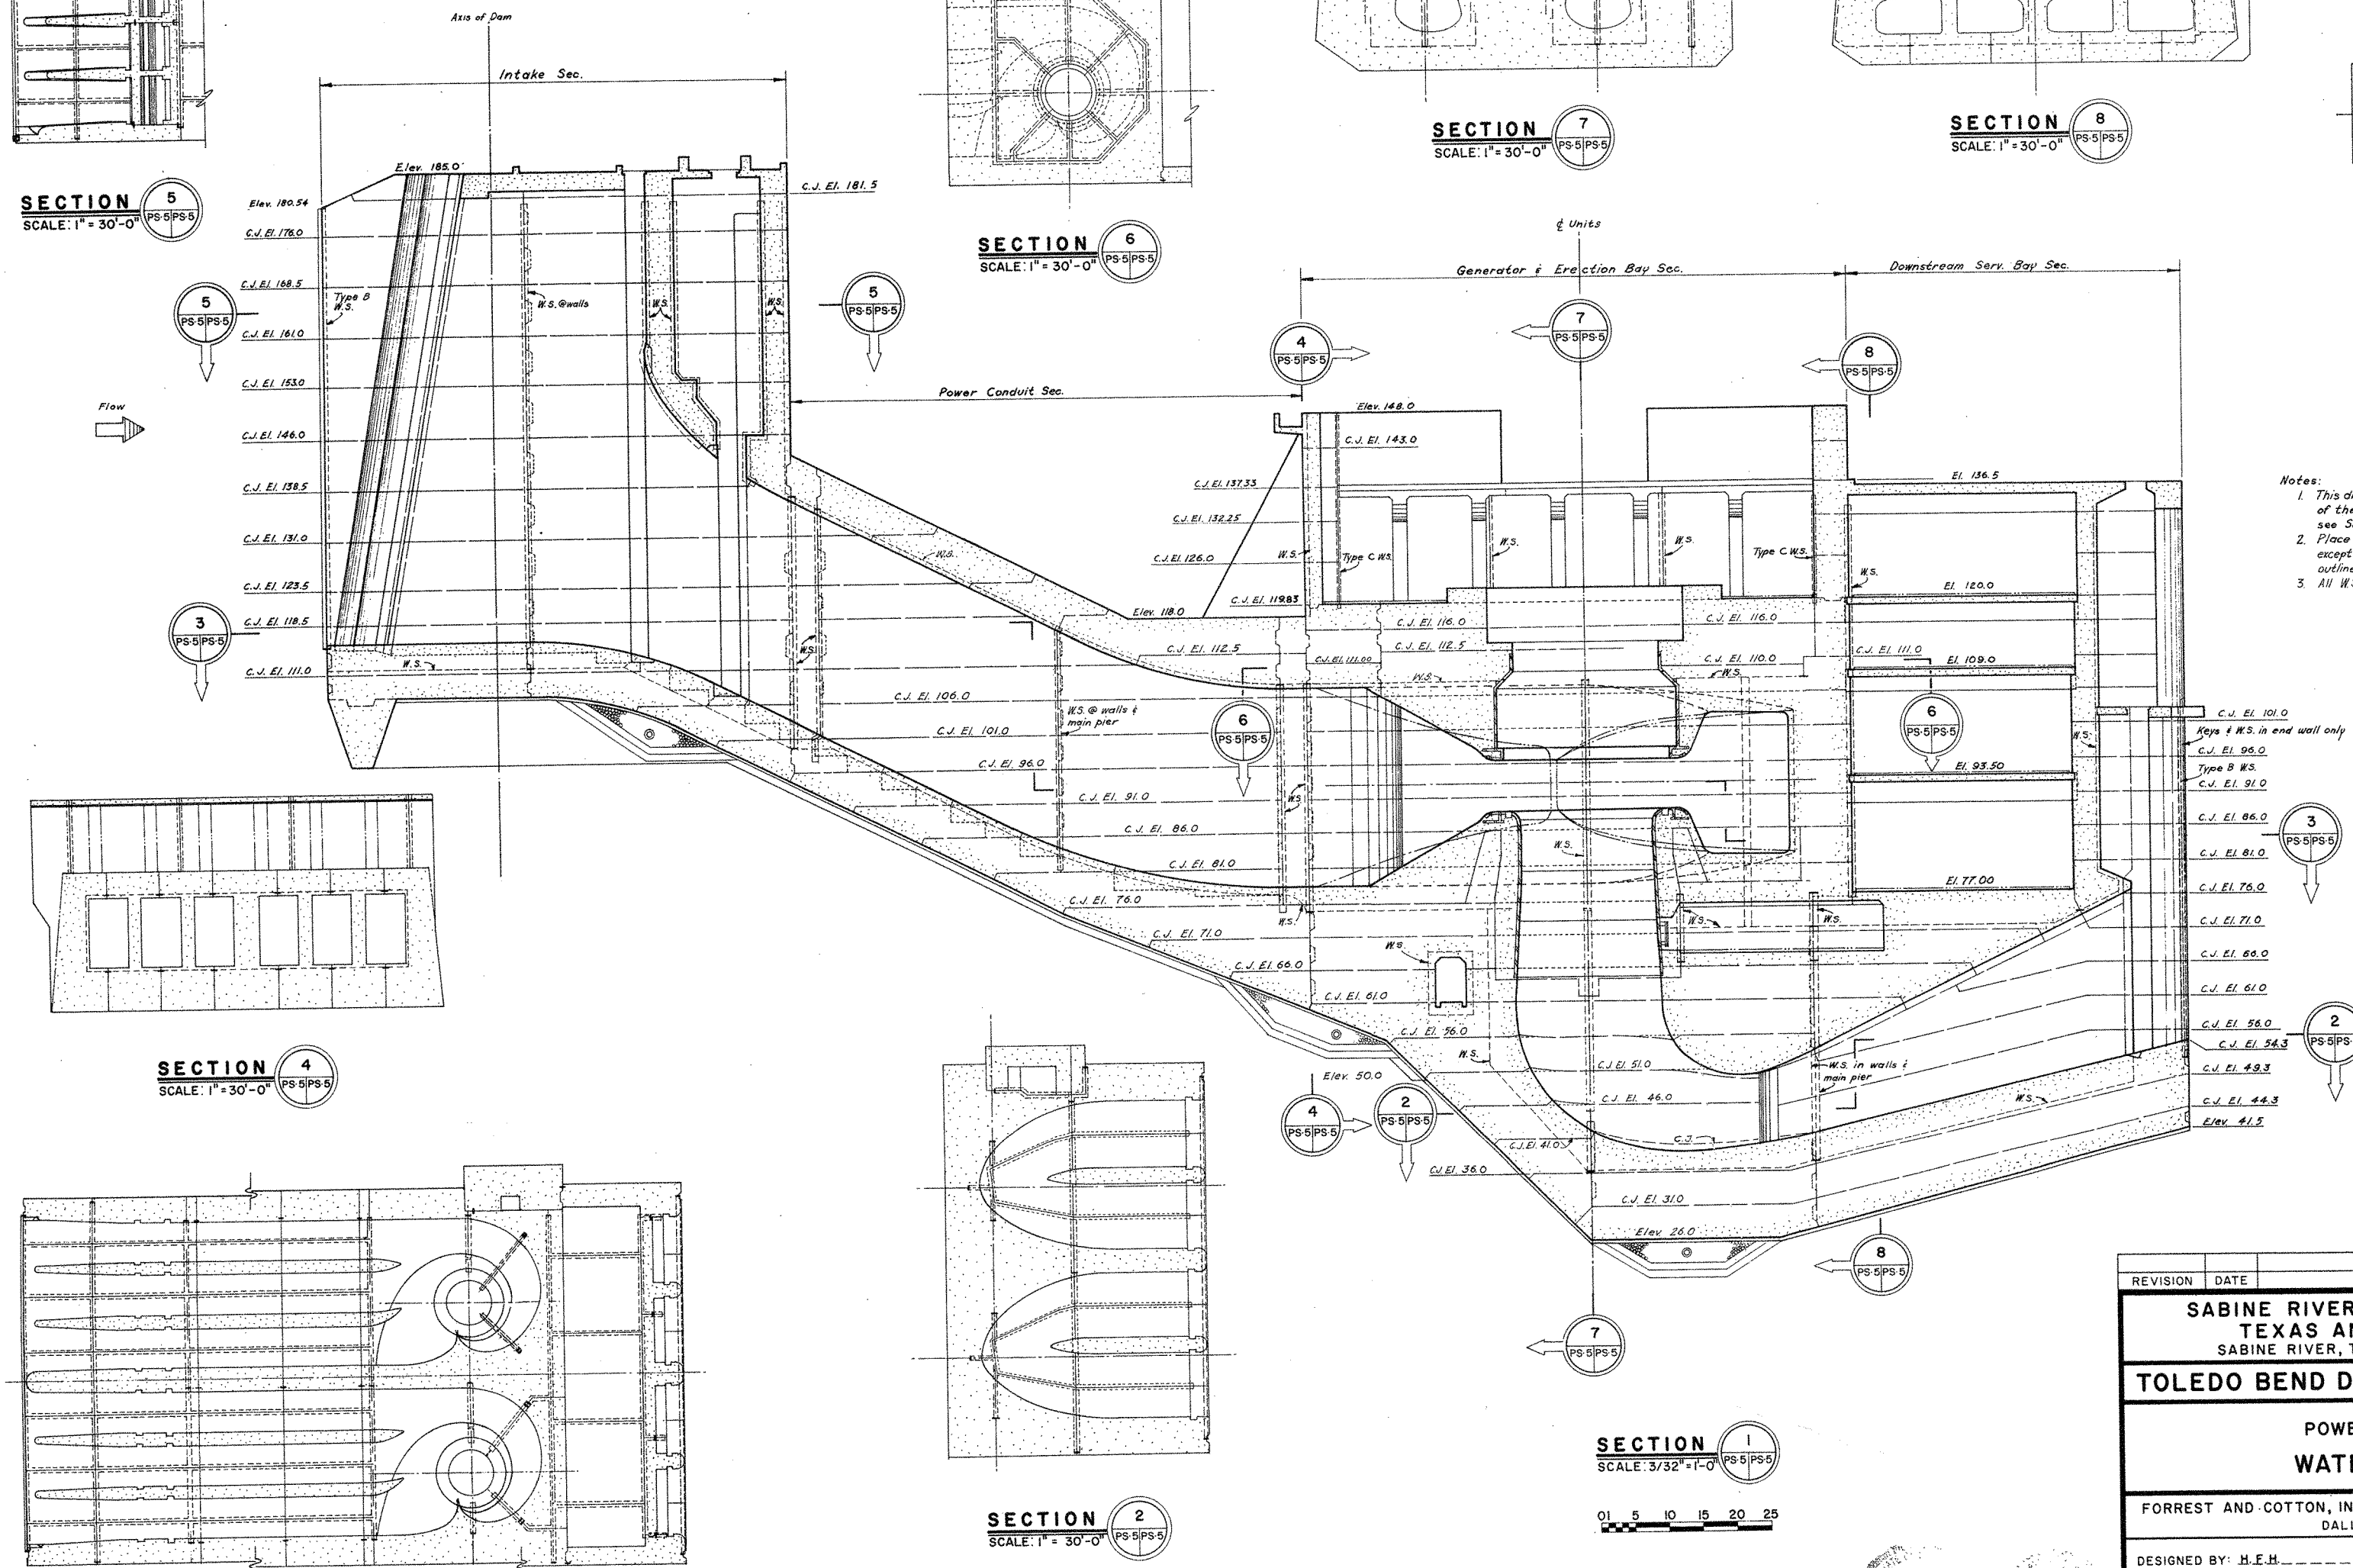


- Notes:**
1. This drawing indicates the general arrangement of the waterstops only. For sizes & details see Sheet PS-4.
 2. Place W.S. 1'-0" from faces of conduits and walls except where indicated otherwise on concrete outline drawings.
 3. All W.S. are type A except as noted.

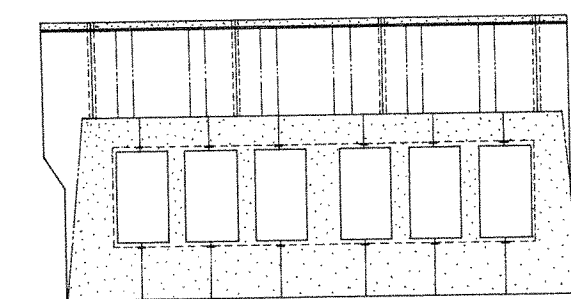

SECTION 4
SCALE: 1" = 30'-0"

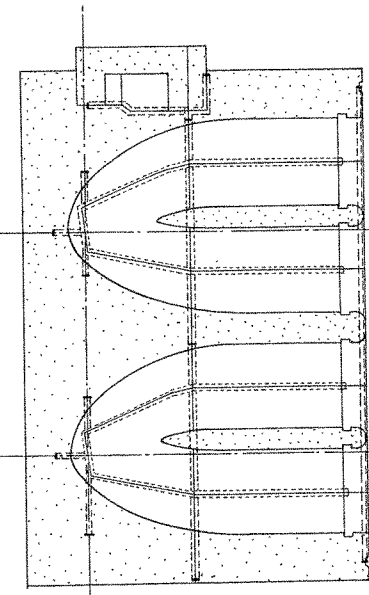

SECTION 2
SCALE: 1" = 30'-0"

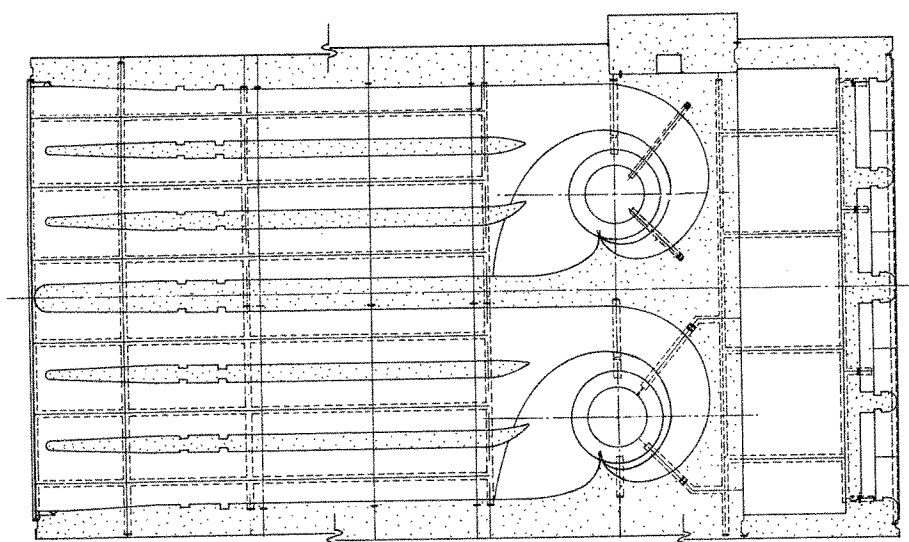

SECTION 3
SCALE: 1" = 30'-0"

SECTION 1
SCALE: 3/32" = 1'-0"

0 5 10 15 20 25

REVISION	DATE	DESCRIPTION	BY
SABINE RIVER AUTHORITIES OF TEXAS AND LOUISIANA TOLEDO BEND DAM AND RESERVOIR POWER PLANT WATERSTOPS			
FORREST AND COTTON, INC. CONSULTING ENGINEERS DALLAS, TEXAS			
DESIGNED BY: H.F.H.	CHECKED BY: H.F.H.		
DRAWN BY: B.E.A.-R.O.W.	RECOMMENDED: A.M.-J.C.B.		
TRACED BY: B.E.A.-R.O.W.	APPROVED: <i>[Signature]</i>		
FILE 522-01-282	DATE 8 Nov. 1963	SCALE AS NOTED	CONTRACT NO. TB-8 SHEET PS-5 OF PS-151